

BID I - STAGE LIGHTING PIPES

BID II - EXHIBIT LIGHTING PIPES  
(NOTE: NOT TYPICAL)

AUDITORIUM SECTION ON C

SIGHTLINE:  
FIRST ROW OF  
AUDIENCE.

DUPLEX RECEPTACLES

DIVIDER BEAM  
"UPSTAGE SIDE"

BID I STAGE LIGHTING  
EXISTING PIPE

- DO NOT OBSTRUCT OPERATION OF DIVIDER PANELS.
- LOAD CIRCUITS MAY SURFACE MOUNT ON UPSTAGE SIDE OF DIVIDER BEAM.
- PIPE LOCATION MAX. 140" UPSTAGE OF DIVIDER BEAM.
- SEE AND FOLLOW ALL NOTES FOR BID I AUDITORIUM PIPE.

BID I - STAGE LIGHTING  
AUDITORIUM PIPE

- HANG 1/4" ID BLACK IRON OR GALV. PIPE ON PIPE HANGERS TO ROOF OR CEILING STRUCTURE OR OTHER METHOD TO SUPPORT 15 LB/FOOT. MINIMUM CLEARANCES:
  - 3" FROM CEILING
  - 2" FROM ANY VERTICAL
- PIPE LOCATION OPTIMUM AS DRAWN. ADJUST AS NECESSARY FOR EASE OF INSTALLATION.
- LOAD CIRCUIT PARALLEL BLADE PLUS 1/2" GROUND DUPLEX RECEPTACLES TO BE FLUSH MOUNTED IN CEILING WITHIN 6" OF PIPE CENTERLINE PIPE AND RECEPTACLE BOXES.
- GROUND PIPE AND RECEPTACLE BOXES.
- PIPE, BOX COVERS ETC. TO BE PAINTED TO MATCH CEILING COLOR (BY LIBRARY STAFF?)

BID I STAGE LIGHTING  
HANG PIPES &  
PROVIDE CIRCUITS  
AS DETAILED.

DIVIDER BEAM  
"DOWNSTAGE SIDE"

EXISTANT  
FLUORESCENT FIXTURES

DIVIDER PANEL  
STORAGE

BID II EXHIBIT LIGHTING

- HANG 1/4" ID BLACK IRON OR GALV. PIPE ON PIPE HANGERS TO ROOF OR CEILING STRUCTURE OR OTHER METHOD TO SUPPORT 10 LB/FOOT. MINIMUM CLEARANCES:
  - 3" FROM CEILING
  - 6" FROM VERTICAL ELEMENT
- PIPE TO HANG NO MORE THAN 4'6" OR LESS THAN 3'6" FROM WALL. OPTIMUM DISTANCE 4'-0" OR AS DRAWN.
- LOAD CIRCUIT PARALLEL BLADE PLUS 1/2" GROUND DUPLEX RECEPTACLES TO BE FLUSH MOUNTED IN CEILING WITHIN 6" OF PIPE CENTERLINE PIPE AND RECEPTACLE BOXES.
- ADAPT WITHIN ABOVE PARAMETERS FOR INSTALLATION CONVENIENCE.
- GROUND PIPE & RECEPT. BOXES.

PROTECTION BOOTH

BID I - LINE CIRCUITS

- PULL 3 x 15A 120V CIRCUITS FROM SPARE BREAKERS IN HALLWAY PANEL.
- CIRCUITS ON MAINS NOT CONTRACTORS.

BID I - STAGE LOAD CIRCUITS

- PROVIDE SURFACE MOUNTED 6-GANG BOX WITH SWITCHES AS FOLLOWS:

LINE LOAD	SWITCH	LOAD	CIRCUIT TYPE
1	A	600W	WALL
2	B	600W	WALL
3	C	600W	WALL
4	D	600W	WALL
5	E	600W	WALL
6	F	600W	WALL

- LOCATE SWITCHBOX SO THAT OPERATOR HAS COMFORTABLE VIEW OF STAGE THRU PROTECTION PORTS WITHOUT OBSTRUCTING SIMULTANEOUS USE OF OTHER PORTS.
- HOUSELIGHTS AND STAGE DIMMERS SHOULD BE OPERATED SIMULTANEOUSLY BY ONE PERSON IF POSSIBLE.
- MAINTAIN CAPABILITY FOR NORMAL TWO PROTECTOR USE OF BOTH PORTS.
- LOAD CIRCUITS ARE #12 CONDUCTOR, IDENTIFY WIRE BOTH ENDS, CIRCUIT ON PANELS OF RECEPTACLE SWITCH.

BID II - EXHIBIT LOAD CIRCUIT

- PROVIDE SURFACE MOUNTED SINGLE SWITCH BOX AND 15A 120V ON/OFF SWITCH TO CONTROL MAX 20 x 75W PAR38 LIGHTS WITH NEAR HOUSELIGHTS AND DOOR.
- LOCATE SWITCH WITHIN HOUSELIGHTS AND DOOR.
- READ AND FOLLOW NOTES #45 ABOVE.

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MAIN LIBRARY AUDITORIUM  
5 WASHINGTON ST. NEWARK, NJ 07101  
LIBRARY RENOVATIONS  
EXHIBIT LIGHTING PLAN  
PROJECT NO. 2002-1518  
W.J. RANNEY ARCHITECT  
NEWARK, NJ 07101



DATE: JUNE 81  
SCALE: 1/2" = 1'-0"

LD-148  
SHEET 1 OF 1

CONTRACTORS TO BID & INSTALL IN COMPLETE COMPLIANCE WITH ALL APPLICABLE FEDERAL, STATE AND LOCAL CODES, ORDINANCES & REGULATIONS.

WILLIAM J. RANNEY IS A DESIGNER AND CONSULTANT AND IS NOT LICENSED AS ARCHITECT OR ENGINEER. THIS DRAWING IS INTENDED TO REPRESENT DESIGN INTENT ONLY. WHERE REQUIRED, APPROVED DRAWINGS AND SPECIFICATIONS MUST BE FURNISHED BY A LICENSED ARCHITECT OR ENGINEER.



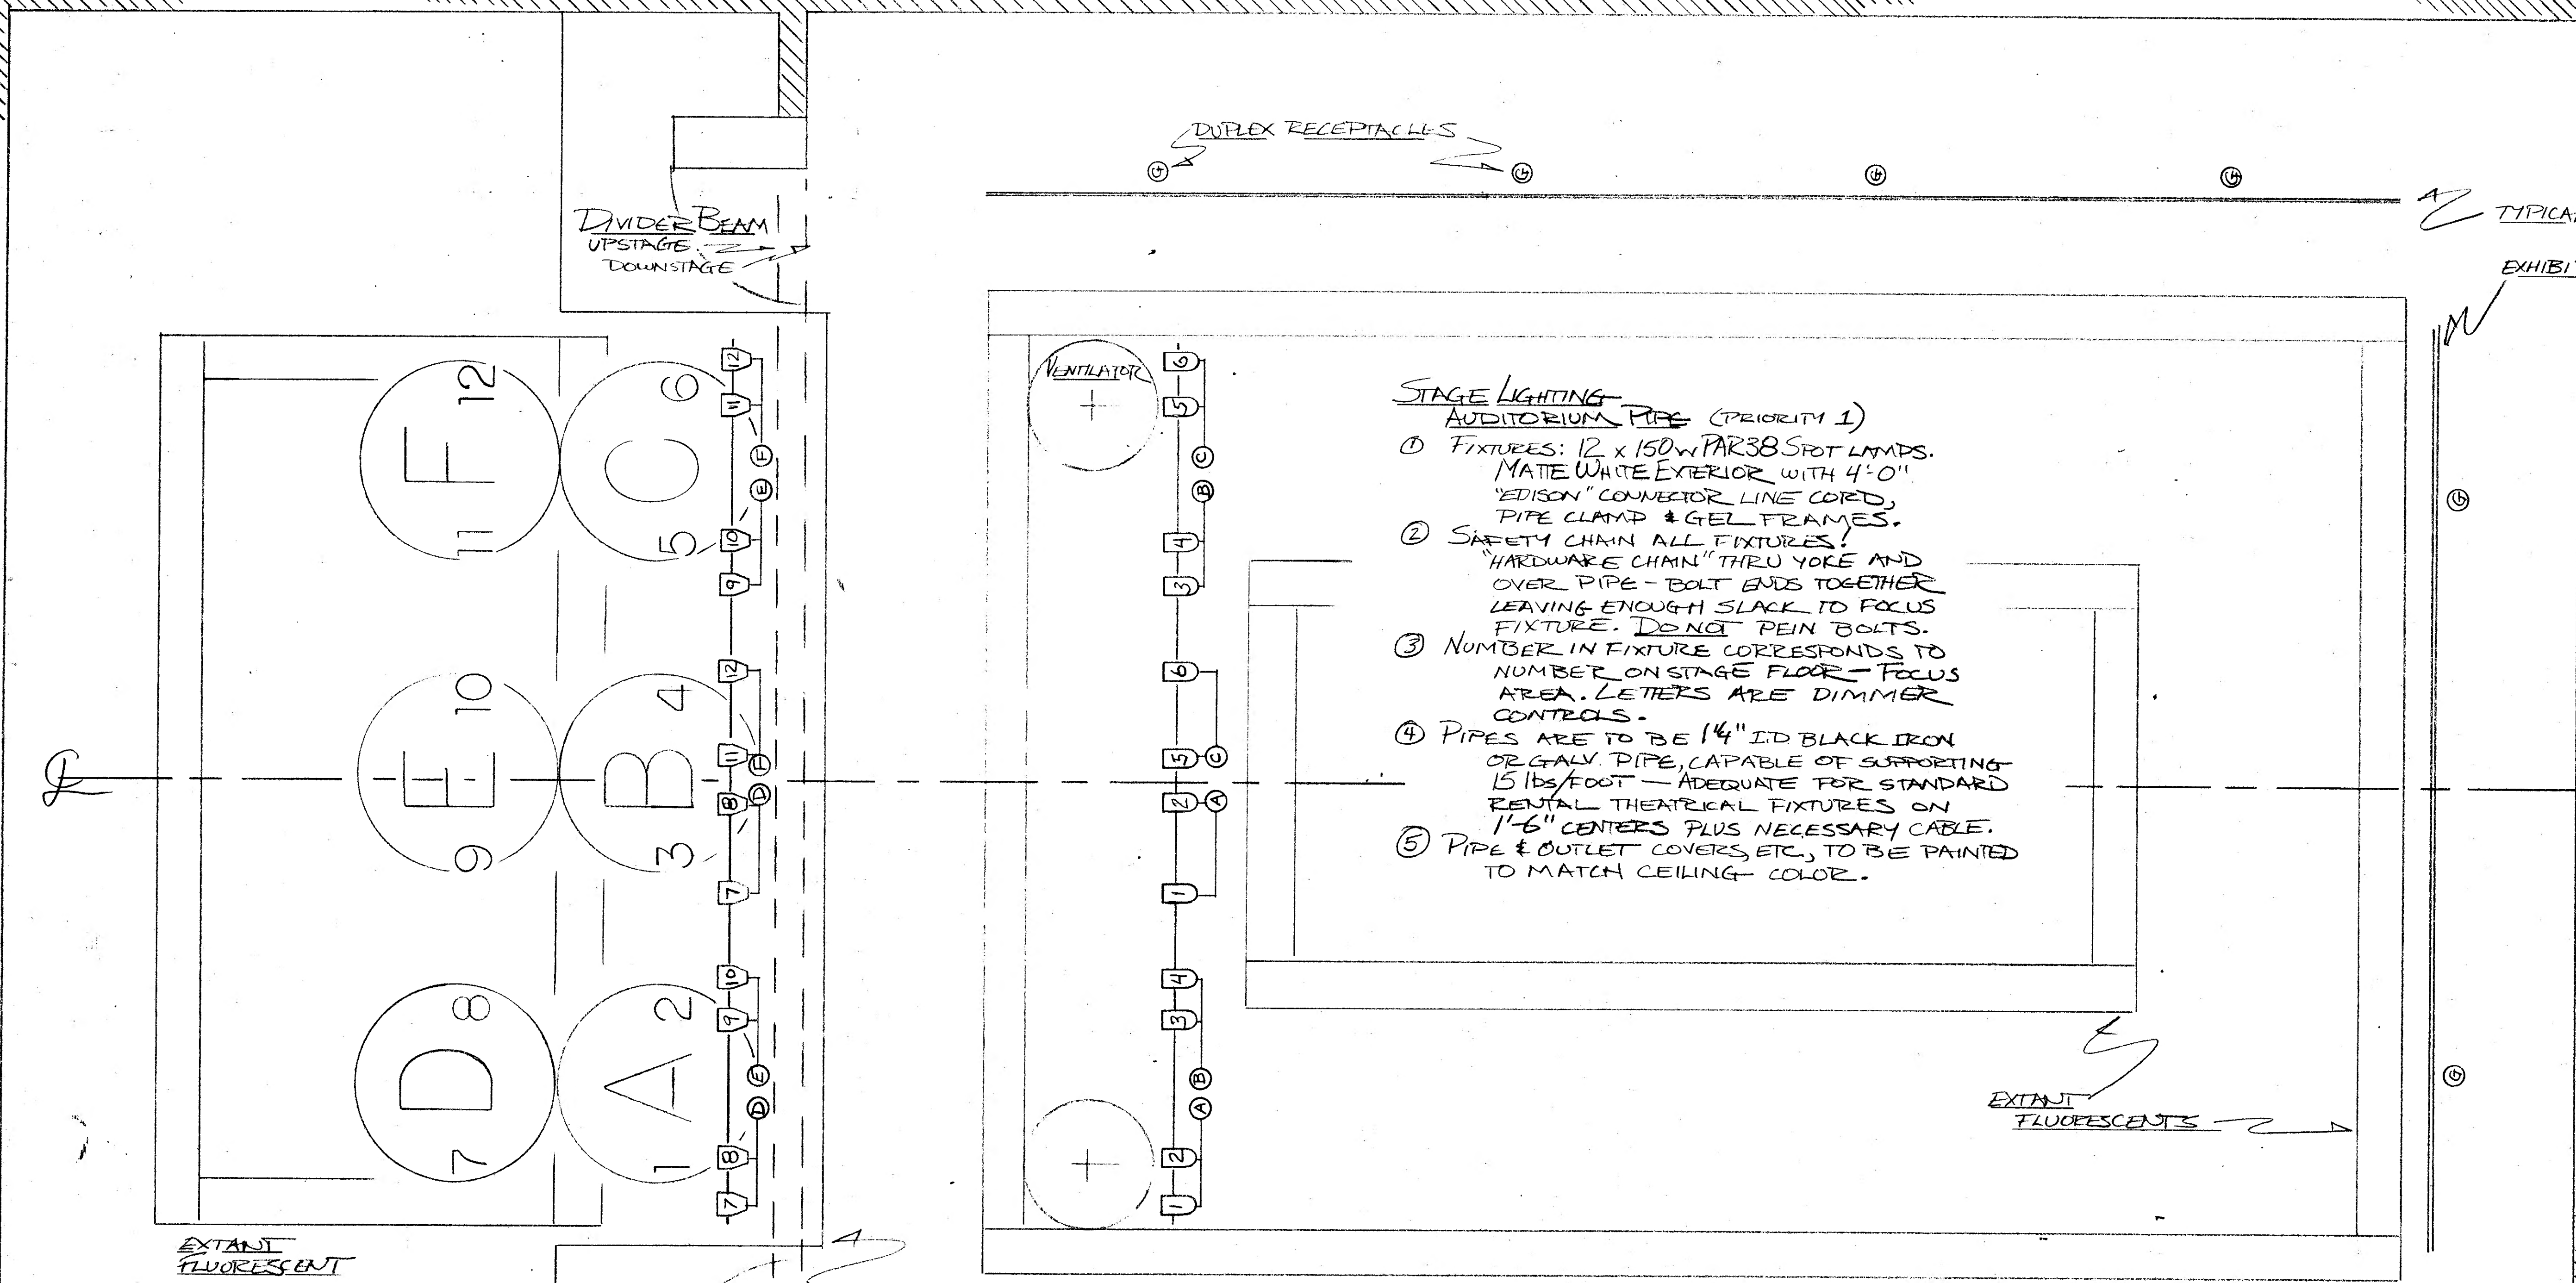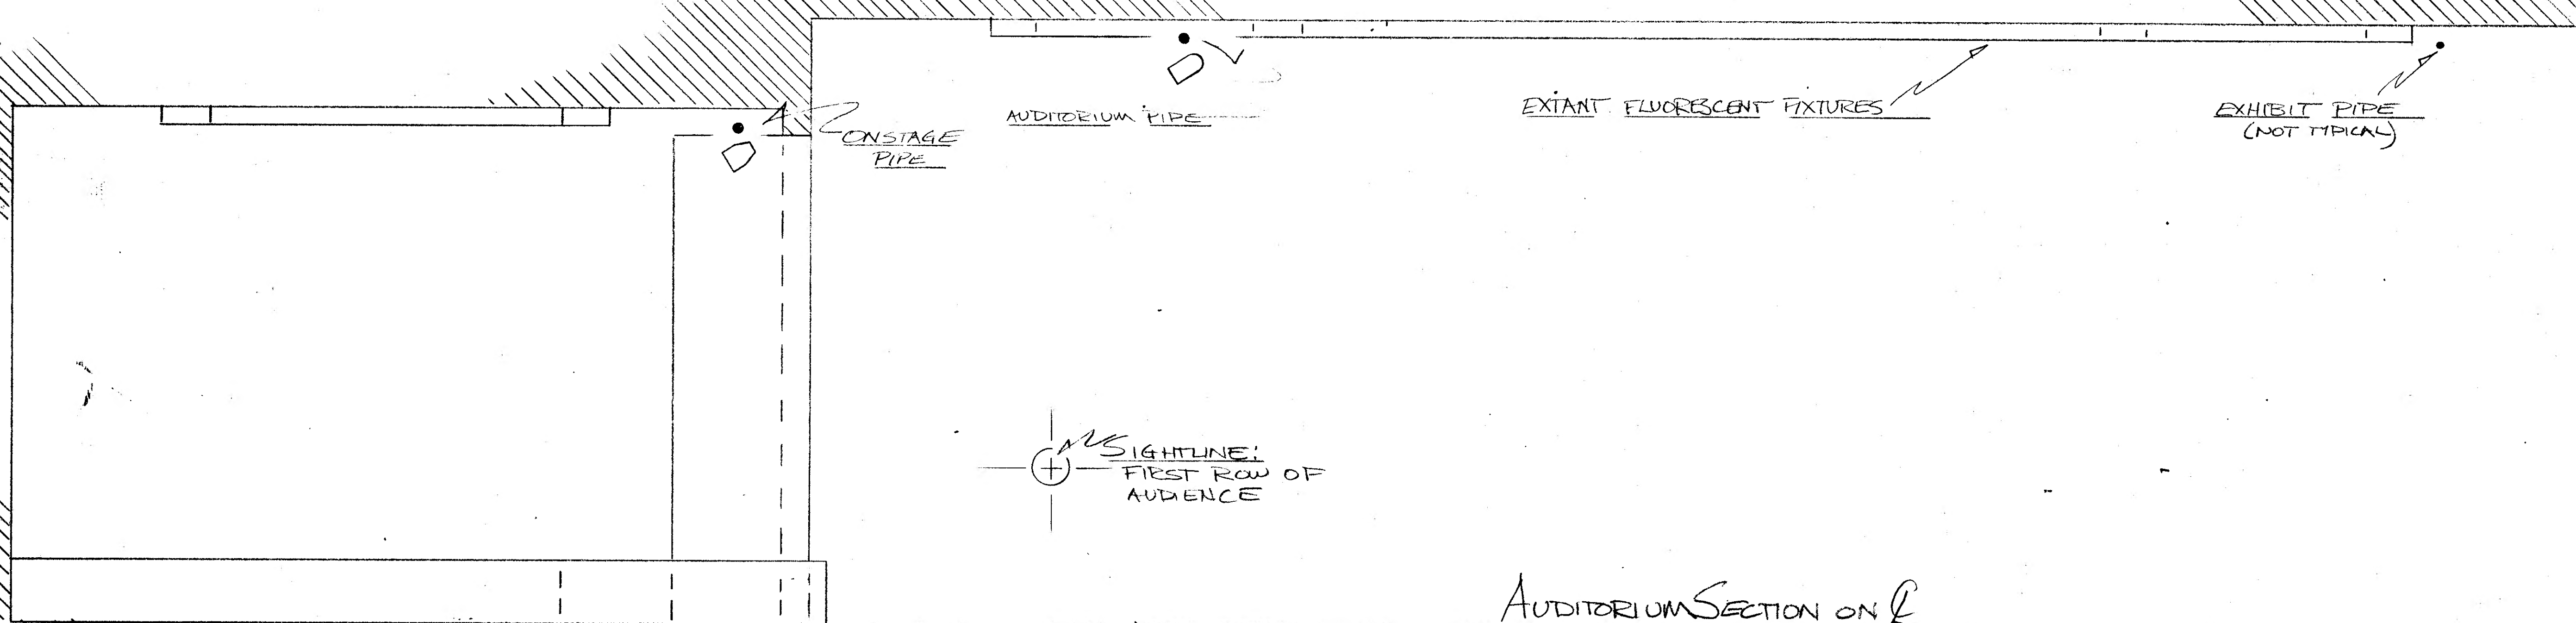

- STAGE LIGHTING ONSTAGE PIPE (PRIORITY 2)**
- ① FIXTURES 12x150W PAR-38 FLOOD LAMPS. MATTE WHITE EXTERIOR, 4'-0" "EDISON" CONNECTOR LINE CORD, PIPE CLAMP & GEL FRAME.
  - ② FOLLOW NOTES 2-5 FOR AUDITORIUM PIPE.
  - ③ POSITIONS OF 4 FIXTURES NEAREST & MAY NEED TO BE ADJUSTED TO CLEAR MOVIE PROJECTIONS.

- EXHIBIT LIGHTING PERIMETER PIPES (PRIORITY 3)**
- ① FIXTURES: 10x75W PAR38 SPOT LAMPS, 10x75W PAR38 FLOOD LAMPS. ALL FIXTURES WITH MATTE WHITE EXTERIOR, 4'-0" "EDISON" CONNECTOR LINE CORD, PIPE CLAMP AND GEL FRAME.
  - ② SAFETY AS PER STAGE LIGHTING FIXTURES.
  - ③ FOCUS AS REQUIRED FOR EXHIBITS.
  - ④ PIPE TO BE 1" I.D. BLACK IRON OR GALV., CAPABLE OF SUPPORTING 10 LBS/FOOT. NOT ADEQUATE FOR THEATRICAL FIXTURES.
  - ⑤ PIPE & OUTLET COVERS TO BE PAINTED TO MATCH CEILING COLOR.

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**MAIN LIBRARY AUDITORIUM**  
 5 WASHINGTON ST. NEWARK, N.J. 07101  
**STAGE LIGHTING PLOT**  
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 DESIGNER 2 COURT ST. NEWARK, N.J. 07101  
 BTJUNE81 1/2" = 1'-0"

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